

NOTE:
PROVISION OF LV + ELV TRAY
THROUGHOUT THE BASEMENT
CARPARK FOR FUTURE USAGE.

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NOTE:
PROVISION OF LV + ELV DUCTING
EXTENDED TO LAST CARPARK SPACE
FOR FUTURE USAGE.


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NOTES


- 1.00 THIS DRAWING IS REPRESENTATIVE OF PRIMARY CONTAINMENT INSTALLATIONS. ANY ADDITIONAL CABLE CONTAINMENT OR CONDUIT RUNS REQUIRED BY THE SPECIFICATION OR REQUIRED BY THE CONTRACTOR TO PROVIDE A COMPLETE INSTALLATION WILL BE DEEMED TO BE INCLUDED.
- 2.00 THIS DRAWING IS TO READ IN CONJUNCTION WITH ALL OTHER SERVICES INSTALLATION DRAWINGS AND WITH CO-ORDINATED MECHANICAL AND ELECTRICAL DRAWINGS PREPARED BY PMEP CONSULTING.
- 3.00 ALL CABLE CONTAINMENT SYSTEMS AT ROOF LEVEL SHALL BE OF GALVANISED STEEL CONSTRUCTION RAISED "OFF" THE ROOF LEVEL ON UNI-STRUT SUPPORT BRACKETS.
- 4.00 A SPACING OF 300mm WILL BE PROVIDED BETWEEN ALL LV. POWER DISTRIBUTION CABLE TRAY / LADDER SYSTEMS AND FIRE DETECTION CONTAINMENT SYSTEMS

CABLE CONTAINMENT SYSTEM REFERENCE KEY

- GALVANISED STEEL 100mm CABLE TRAY FOR E-CAR CHARGER.
- GALVANISED STEEL CABLE TRAY FOR ELV CABLING
- UNDERGROUND LV DUCTWORK
- UNDERGROUND ELV DUCTWORK
- MANHOLE (LV-GREEN), (ELV-BLUE)
- E-CAR CHARGER POINT

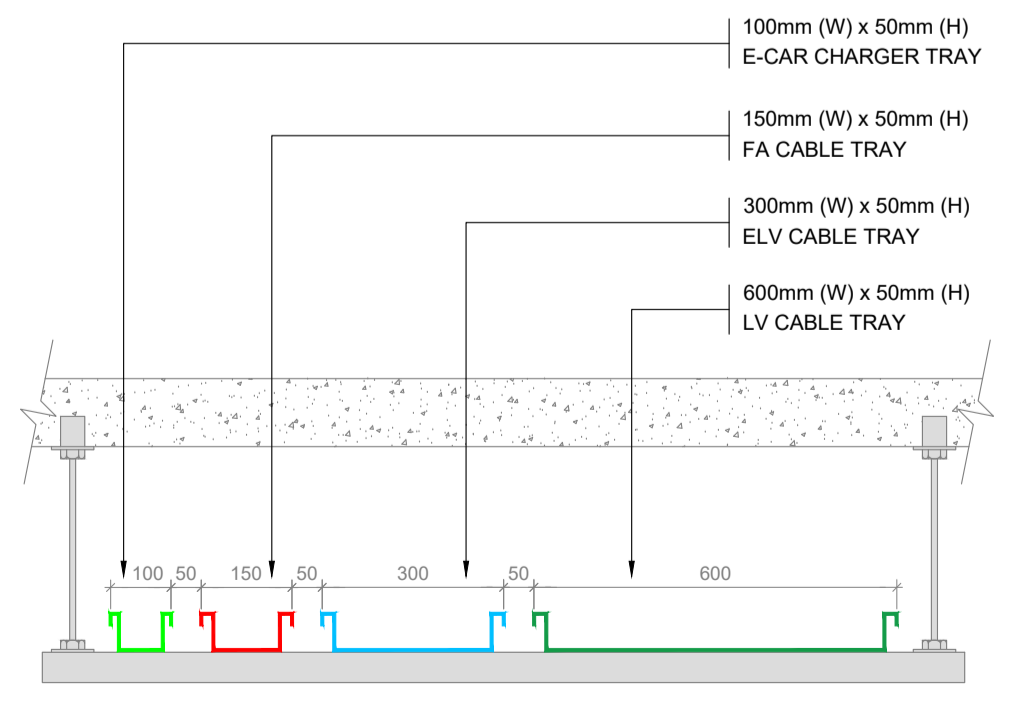

SECTION DETAIL - CABLE CONTAINMENT
SCALE 1:200

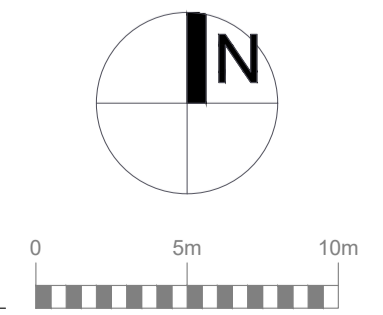

REV	DESCRIPTION	DRN	ENG	APP	DATE
P7	PLANNING	RP	RP	RF	28/06/19
P6	PLANNING	BH	RP	RF	27/06/19
P5	PLANNING	PF	RP	RF	21/06/19
P4	PRE-APPLICATION ISSUE	PF	RP	RF	06/06/19
P3	PRE-APPLICATION ISSUE	TS	RP	RF	20/05/19
P2	PRE-APPLICATION ISSUE	TS	RP	RF	15/03/19
P1	PRELIMINARY ISSUE	TS	RF	DR	01/03/19

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PROJECT
RESIDENTIAL DEVELOPMENT
AT CHURCHVIEW ROAD,
KILLINEY, CO DUBLIN

CLIENT
STRAND COURT LIMITED

ARCHITECT
O'MAHONY PIKE
ARCHITECTS URBAN DESIGNERS INTERIOR DESIGNERS

DRAWING TITLE
ELECTRICAL SERVICES INSTALLATION
E-CAR CHARGING PROPOSED INFRASTRUCTURE
SITE PLAN

SCALE	SHEET SIZE	DRAWING No.	REV.
1:500 @ A3 1:250 @ A1	A1	P017-PMEP-00-00-DR-E-02	P7